




















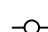



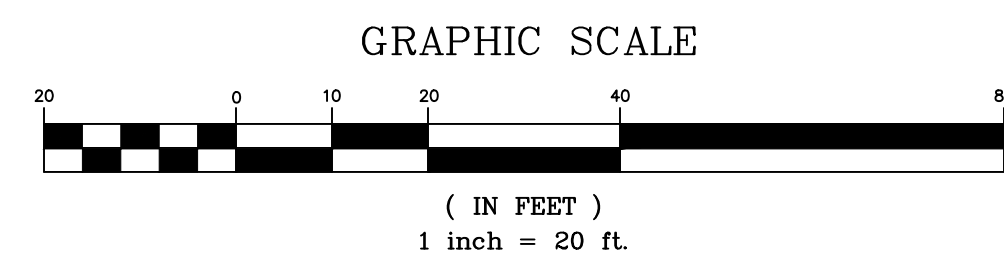

	EXISTING CONTOUR LINE		EXISTING STONE WALL
	PROPOSED CONTOUR LINE		EXISTING FENCE
	EXISTING SPOT GRADE		EXISTING TIE LINE
	PROPOSED SPOT GRADE		EXISTING DECIDUOUS TREE
	EXISTING CURB LINE		EXISTING EVERGREEN TREE
	PROPOSED CURB LINE		EXISTING SHRUB
	EXISTING INLET		EXISTING TREE TO BE REMOVED
	PROPOSED INLET		PROPOSED DECIDUOUS TREE
	EXISTING STORM/SAN PIPE		INLET SEDIMENT CONTROL DEVICE
	PROPOSED STORM SEWER		SILT FENCE
	EXISTING GAS LINE		TOPSOIL STOCKPILE
	EXISTING OVERHEAD WIRE		LIMIT OF DISTURBANCE
	EXISTING SITE LIGHT		SIGN

GENERAL NOTES:

1. FERRIERO ENGINEERING, INC. DID NOT PERFORM A BOUNDARY SURVEY OF THIS PROPERTY. NO PROPERTY LINES ARE SHOWN.
2. THIS SURVEY REPRESENTS FIELD CONDITIONS AS OF OCTOBER 5, 2023.
3. THE UTILITIES SHOWN HAVE BEEN LOCATED FROM EVIDENCE OBSERVED ON THE SURFACE ONLY OR HAVE BEEN SHOWN GRAPHICALLY PER SUPPLIED MATERIALS. FERRIERO ENGINEERING, INC. MAKES NO GUARANTEES THAT THE UTILITIES SHOWN COMPRISE ALL SUCH UTILITIES IN THE AREA, EITHER IN-SERVICE OR ABANDONED. FERRIERO ENGINEERING, INC. FURTHER DOES NOT WARRANT THAT THE UNDERGROUND UTILITIES SHOWN ARE IN THE EXACT LOCATION INDICATED. FERRIERO ENGINEERING, INC. HAS NO PHYSICALLY LOCATED THE UNDERGROUND UTILITIES.
4. PREMISES ARE COMMONLY KNOWN AS 141 GOULD AVENUE, NORTH CALDWELL, NEW JERSEY.
5. ALSO SHOWN AS A PORTION OF LOT 39 IN BLOCK 1200 AS SHOWN ON THE OFFICIAL TAX MAPS OF THE BOROUGH OF NORTH CALDWELL, ESSEX COUNTY, NEW JERSEY.
6. THE PROJECT VERTICAL DATUM IS BASED UPON NAVD 88 DERIVED USING THE RECOVERED BENCHMARK.
7. IF THIS DOCUMENT DOES NOT CONTAIN A RAISED SEAL OF THE UNDERSIGNED PROFESSIONAL, IT IS NOT AN AUTHORIZED ORIGINAL DOCUMENT.

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# BOSWELL ENGINEERING

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ENGINEERS - PLANNERS - SURVEYORS - SCIENTISTS

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N.J. CERTIFICATE OF AUTHORIZATION No. 24GA27958000

PAUL W. FERRIERO

**DRAFT**


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PROFESSIONAL ENGINEER N.J. LIC. 32978


<p>GOULD AVENUE ATHLETIC COURTS</p> <p><b>DEMOLITION PLAN</b></p> <p>BOROUGH OF NORTH CALDWELL</p>				
ESSEX COUNTY			NEW JERSEY	
SURVEYED BY: xxx	DESIGNED BY: xxx	SCALE: X" = XX'	JOB NO. 23NC103	DATE 1/5/2024
DRAWN BY: EJS	CHECKED BY: PWF			
CADD FILE: 23NC103_BASEMAP.DWG		SHEET <span style="font-size: 1.5em;">2</span> OF <span style="font-size: 1.5em;">8</span>		




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NO.	DATE	DESCRIPTION	SURVEYED BY	DRAWN BY	DESIGNED BY	CHECKED BY

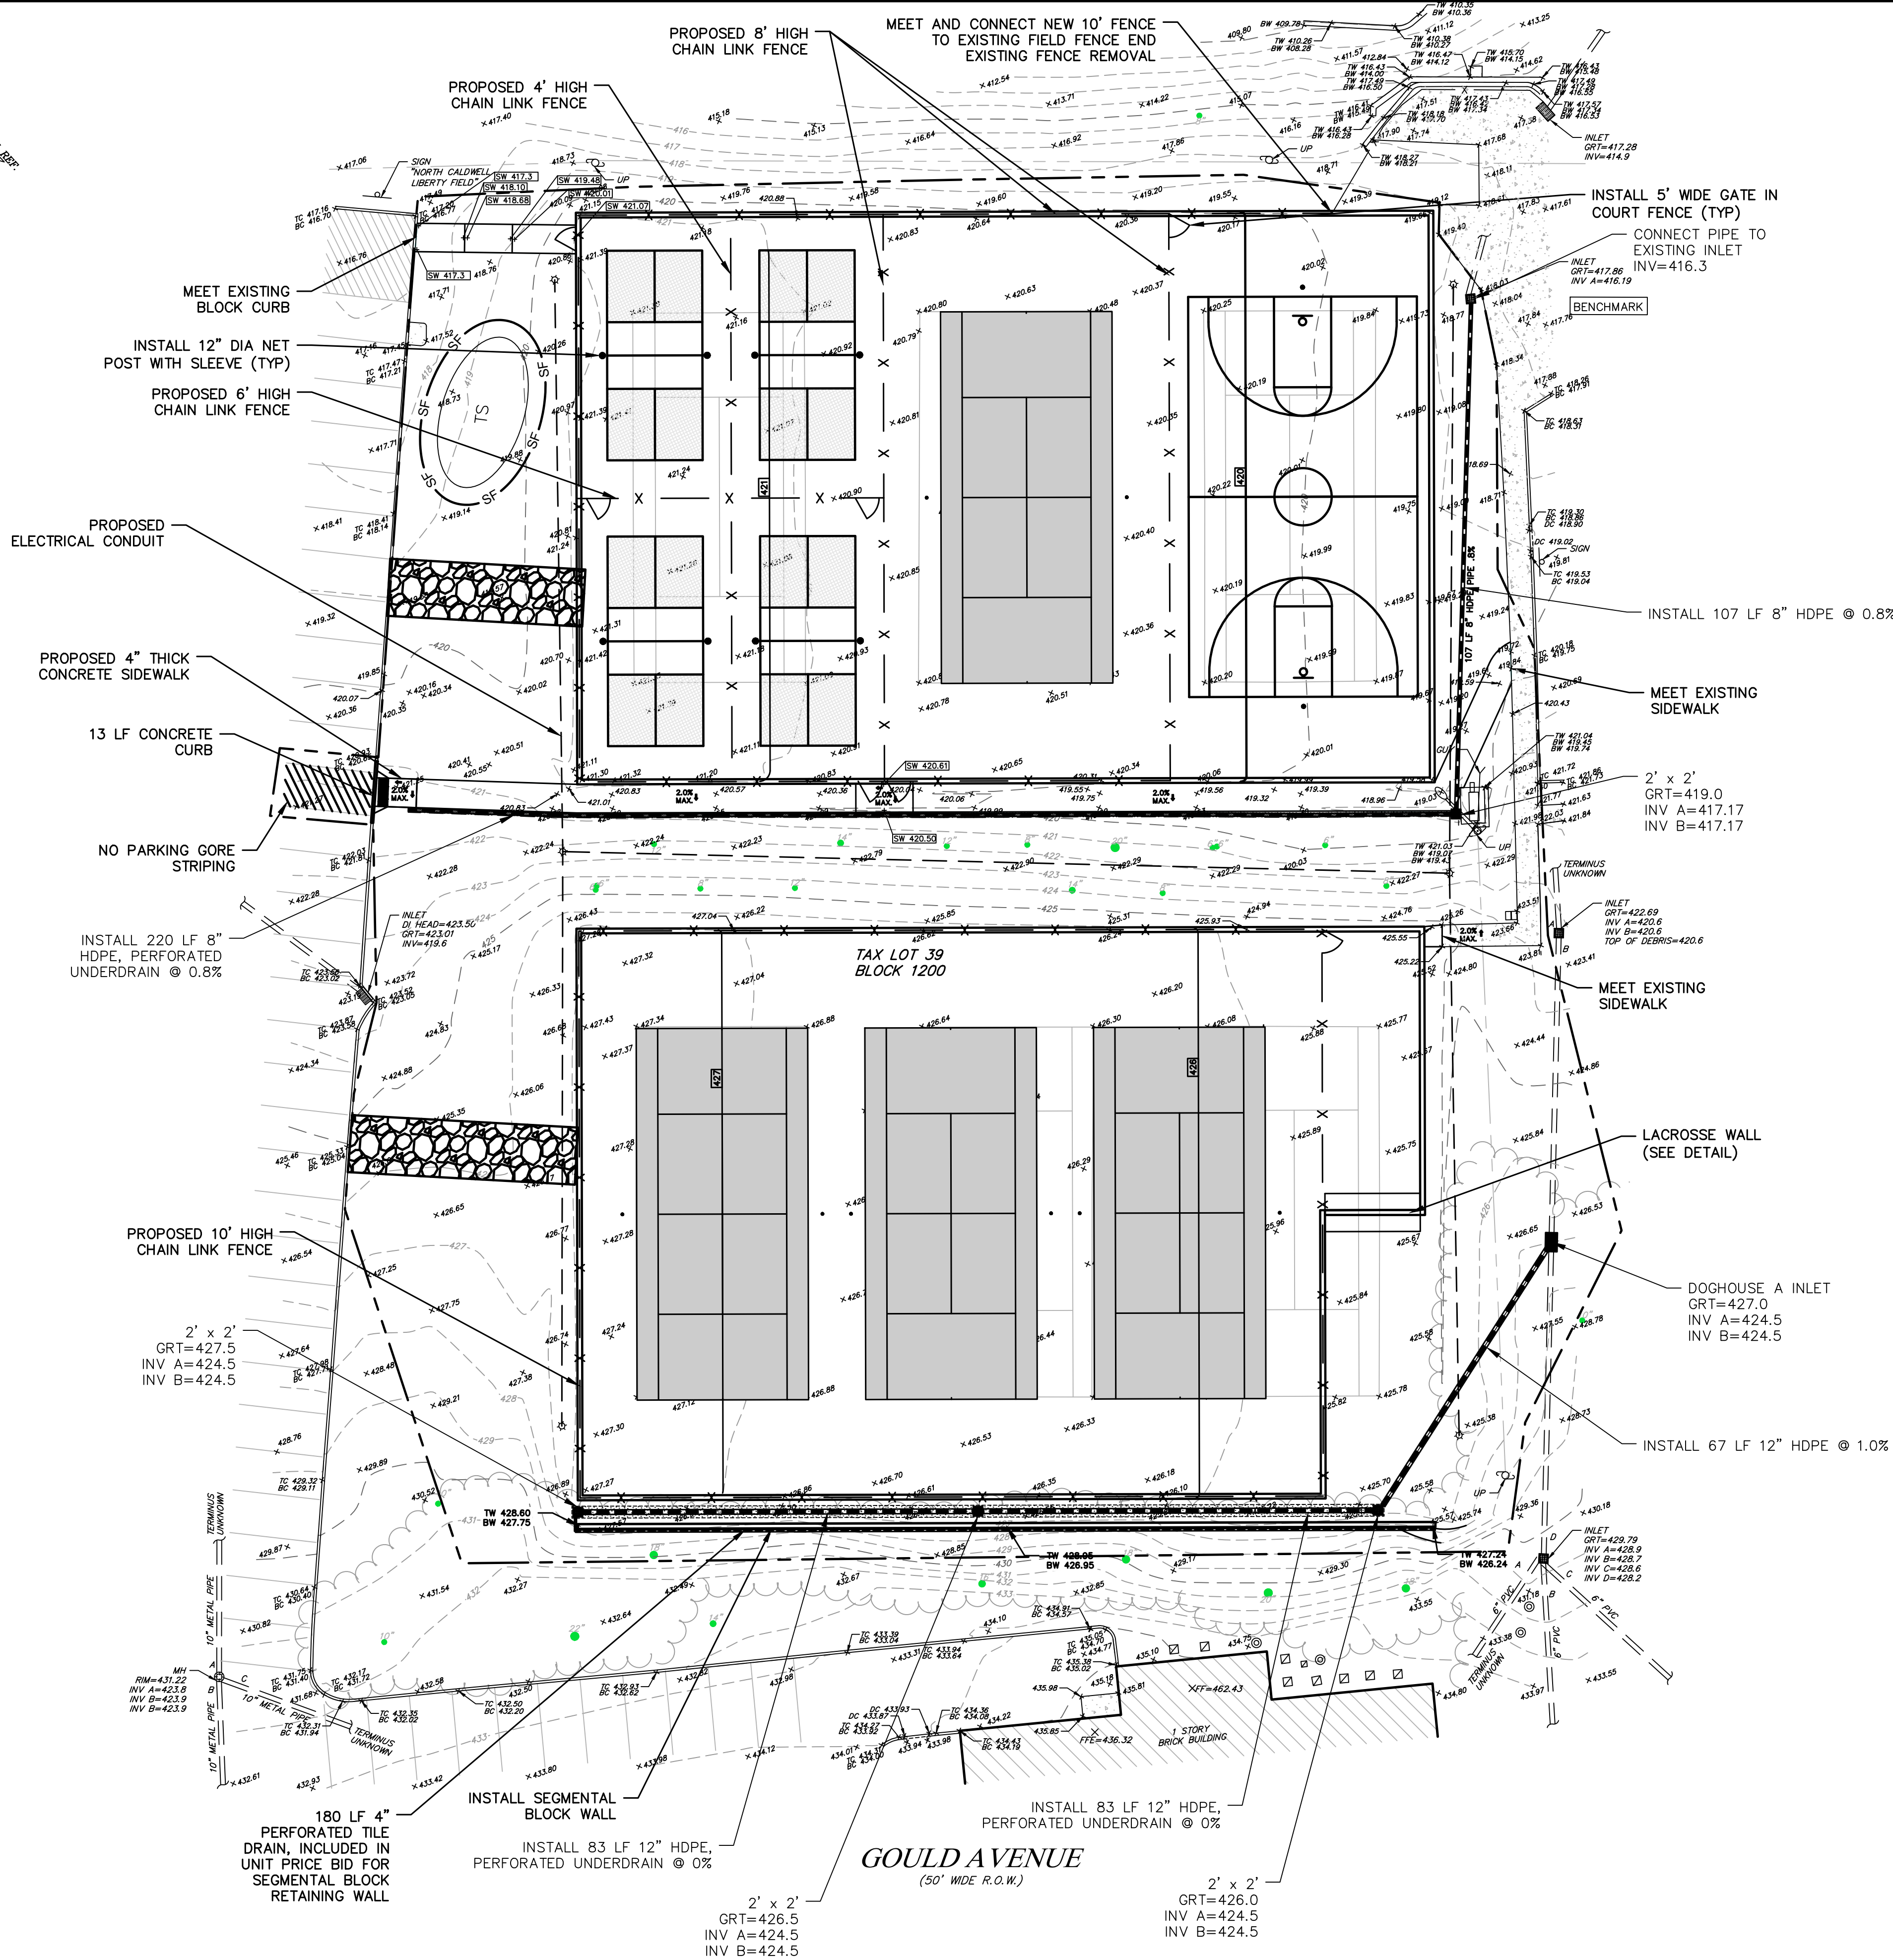

**Boswell Engineering**  
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PAUL W. FERRIERO  
**DRAFT**  
PROFESSIONAL ENGINEER N.J. LIC. 32978

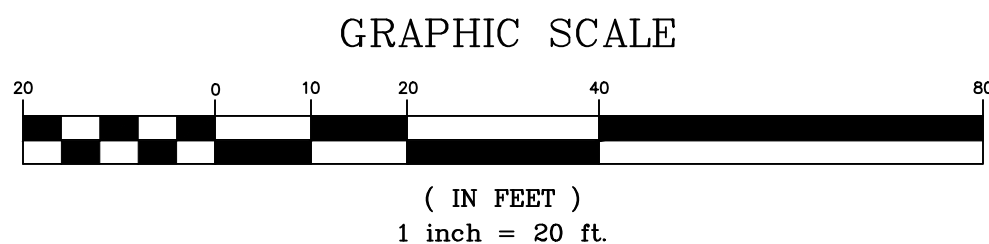GOULD AVENUE ATHLETIC COURTS  
CONSTRUCTION PLAN  
BOROUGH OF NORTH CALDWELL  
ESSEX COUNTY NEW JERSEY  
SURVEYED BY: xxx DESIGNED BY: xxx SCALE: JOB NO. DATE  
DRAWN BY: EJS CHECKED BY: PWF 1" = 20' 23NC103 1/5/2024  
CADD FILE: 23NC103\_BASEMAP.DWG SHEET 3 OF 8



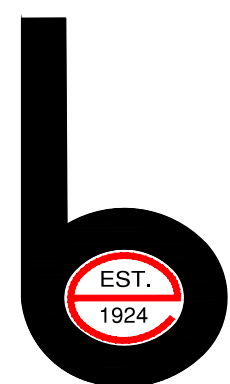



1. ALL SOIL EROSION AND SEDIMENT CONTROL PRACTICES ON THIS PLAN WILL BE CONSTRUCTED IN ACCORDANCE WITH THE "NEW JERSEY STANDARDS FOR SOIL EROSION AND SEDIMENT CONTROL", 7TH EDITION LAST REVISED JULY 17, EFFECTIVE DECEMBER 2017. THESE MEASURES WILL BE INSTALLED PRIOR TO ANY MAJOR SOIL DISTURBANCE OR IN THEIR PROPER SEQUENCE AND MAINTAINED UNTIL PERMANENT PROTECTION IS ESTABLISHED.
2. ALL SOIL TO BE EXPOSED OR STOCKPILED FOR A PERIOD OF GREATER THAN 14 DAYS, AND NOT UNDER ACTIVE CONSTRUCTION, WILL BE TEMPORARILY SEEDED AND HAY MULCHED OR OTHERWISE PROVIDED WITH VEGETATIVE COVER. THIS TEMPORARY COVER SHALL BE MAINTAINED UNTIL SUCH TIME WHEREBY PERMANENT RESTABILIZATION IS ESTABLISHED.
3. SEEDING DATES: THE FOLLOWING SEEDING DATES ARE RECOMMENDED TO BEST ESTABLISH PERMANENT VEGETATIVE COVER WITHIN MOST LOCATIONS IN THE HEPSCOD: SPRING - 4/15 AND FALL - 9/15 - 10/1.
4. SEDIMENT FENCES ARE TO BE PROPERLY TRENCHED AND MAINTAINED UNTIL PERMANENT VEGETATIVE COVER IS ESTABLISHED.
5. ALL STORM DRAINAGE INLETS SHALL BE PROTECTED BY ONE OF THE PRACTICES ACCEPTED IN THE STANDARDS, AND PROTECTION SHALL REMAIN UNTIL PERMANENT STABILIZATION HAS BEEN ESTABLISHED. STORM DRAINAGE OUTLET POINTS SHALL BE PROTECTED AS REQUIRED BEFORE THEY BECOME FUNCTIONAL.
6. MULCH MATERIALS SHALL BE UN-ROOTED SMALL GRASS STRAW APPLIED AT THE RATE OF 70 TO 90 POUNDS PER 1,000 SQUARE FEET AND ANCHORED WITH A RAKE OR ANCHORING TOOL. A LIQUID MULCH BINDER MAY BE USED. HOWEVER, OTHER SUITABLE MATERIALS MAY BE USED IF APPROVED BY THE SOIL CONSERVATION DISTRICT.
7. ALL EROSION CONTROL DEVICES SHALL BE PERIODICALLY INSPECTED, MAINTAINED AND CORRECTED BY THE CONTRACTOR. ANY DAMAGE INCURRED BY EROSION SHALL BE RECTIFIED IMMEDIATELY.
8. THE HUDSON-ESSEX-PASSAIC SOIL CONSERVATION DISTRICT WILL BE NOTIFIED IN WRITING AT LEAST 48 HOURS PRIOR TO ANY SOIL DISTURBING ACTIVITIES. FAX - (862) 333-4505 OR EMAIL - COMA@HESCD.ORG
9. THIS APPLICANT MUST OBTAIN A DISTRICT ISSUED REPORT OF COMPLIANCE PRIOR TO APPLYING FOR THE CERTIFICATE OF OCCUPANCY OR TEMPORARY CERTIFICATE OF OCCUPANCY FROM THE RESPECTIVE MUNICIPALITY, NJ - DCA OR ANY OTHER CONTROLLING AGENCY. CONTACT THE DISTRICT AT 862-333-4505 TO REQUEST A FINAL INSPECTION, GIVING ADVANCED NOTICE UPON COMPLETION OF THE RESTABILIZATION MEASURES. A PERFORMANCE DEPOSIT MAY BE POSTED WITH THE DISTRICT WHEN WINTER WEATHER OR SNOW COVER PROHIBITS THE PROPER APPLICATION OF SEED, MULCH, FERTILIZER OR HYDRO SEED.
10. PAVED ROADWAYS WILL BE KEPT OPEN ALL TIMES. IT IS NOT TO UTILIZE A FIRE OR GARDEN HOSE TO CLEAN ROADS UNLESS THE RUNOFF IS DIRECTED TO A PROPERLY DESIGNED AND FUNCTIONING SEDIMENT BASIN. WATER PUMPED OUT OF THE EXCAVATED AREAS CONTAINS SEDIMENTS THAT MUST BE REMOVED PRIOR TO DISCHARGING TO RECEIVING BODIES OF WATER USING REMOVABLE PUMPING STATIONS, SUMP PITS, PORTABLE SEDIMENTATION TANKS AND/OR SILT CONTROL BAGS.
11. ALL SURFACES HAVING LAWN OR LANDSCAPING AS FINAL COVER ARE TO BE PROVIDED TPOING PRIOR TO RE-SEEDING, SODDING OR PLANTING. A DEPTH OF 5 INCHES, FIRMED AND PLACED, IS REQUIRED AS PER THE STANDARDS FOR TPOING SLURRY AND GRADING. LAST REVISED DECEMBER 2017.
12. ALL PLAN REVIEWS MUST BE SUBMITTED TO THE DISTRICT FOR PROPER REVIEW AND APPROVAL.
13. A CRUSHED STONE WHEEL CLEANING TRACKING-PAD IS TO BE INSTALLED AT ALL SITE EXITS USING 2 1/4" CRUSHED ANGULAR STONE (ASTM 2 OR 3) TO A MINIMUM LENGTH OF 50 FEET AND MINIMUM DEPTH OF 6". ALL DRIVEWAYS MUST BE PROVIDED WITH CRUSHED STONE UNTIL PAVING IS COMPLETE.
14. STEEP SLOPES INCURRING DISTURBANCE MAY REQUIRE ADDITIONAL STABILIZATION MEASURES. THESE SPECIAL MEASURES SHALL BE DESIGNED BY THE APPLICANT'S ENGINEER AND APPROVED BY THE SOIL CONSERVATION DISTRICT.
15. THE HUDSON-ESSEX-PASSAIC SOIL CONSERVATION DISTRICT SHALL BE NOTIFIED IN WRITING, FOR THE SALE OF ANY PORTION OF THE PROJECT OR FOR THE SALE OF INDIVIDUAL LOTS, NEW OWNERS' INFORMATION SHALL BE PROVIDED. ADDITIONAL MEASURES DEEMED NECESSARY BY DISTRICT OFFICIALS SHALL BE IMPLEMENTED AS CONDITIONS WARRANT.

THE FOLLOWING METHODS SHOULD BE CONSIDERED FOR CONTROLLING DUST:

MULCHES - SEE STANDARDS FOR STABILIZATION WITH MULCHES ONLY (PG. 5-1).

VEGETATIVE COVER - SEE STANDARDS FOR TEMPORARY VEGETATIVE COVER (PG. 7-1), PERMANENT VEGETATIVE COVER FOR SOIL STABILIZATION (PG. 4-1), AND PERMANENT STABILIZATION WITH SOD (PG. 6-1).

SPRAY ON ADHESIVES - ON MINERAL SOILS (NOT EFFECTIVE ON MUCK SOILS). KEEP TRAFFIC OFF THESE AREAS.

TILLAGE - TO ROUGHEN SURFACE AND BRING CLODS TO THE SURFACE. THIS IS A TEMPORARY EMERGENCY MEASURE WHICH SHOULD BE USED BEFORE SOIL BLOWING STARTS. BEGIN PLOWING ON WINDWARD SIDE OF SITE. TYPE OF PLOWS AVAILABLE ARE: 12 INVERTED AND SPRING-TOOTHED HARROWS ARE EXAMPLES OF EQUIPMENT WHICH MAY PRODUCE THE DESIRED EFFECT.

SPRINKLING - SITE IS SPRINKLED UNTIL SURFACE IS WET.

BARRIERS - SOLID BOARD FENCES, SNOW FENCES, BURLAP FENCES, GRATE WALLS, BALES OF HAY, AND SIMILAR MATERIAL CAN BE USED TO CONTROL AIR CURRENTS AND SOIL BLOWING.

CALCIUM CHLORIDE - SHALL BE IN THE FORM OF LOOSE, DRY GRANULES OF FLAKES FINE ENOUGH TO FEED THROUGH COMMONLY USED SPREADERS AT A RATE THAT WILL KEEP SURFACE MOIST BUT NOT CAUSE POLLUTION OR CLAY DAMAGING. USE IN STEEPER AREAS.

WASHING - USED TO PREVENT SOIL FROM ACCUMULATING ON SURFACES. THEN USE PLANTS OR OTHER METHODS TO PREVENT WASHING INTO STREAMS OR ACCUMULATION AROUND PLANTS.

STONE - COVER SURFACE WITH CRUSHED STONE OR COARSE GRAVEL.

- a. APPLY GROUND LIMESTONE AT A RATE OF 90 LBS. PER 1000 SF.
- b. APPLY FERTILIZER (10–20–10) AT A RATE OF 11 LBS/1000 S.F.
- c. APPLY PERENNIAL RYEGRASS SEED AT A RATE OF 1 LB/1000 S.F. AND ANNUAL RYEGRASS AT 1 LB. PER 1000 S.F.
- d. MULCH STOCKPILE WITH STRAW OR HAY AT RATE OF 90 LBS./1000 S.F.
- e. APPLY A LIQUID MULCH BINDER OR TACK TO STRAW OR HAY MULCH.
- f. PROPERLY ENTRENCH A SILT FENCE AT THE BOTTOM OF THE STOCKPILE.


- APPLY GROUND LIMESTONE AT A RATE OF 90 LBS. PER 1000 SF.
- APPLY FERTILIZER (10–20–10) AT A RATE OF 11 LBS./1000 SF.
- APPLY PERENNIAL RYEGRASS SEED AT A RATE OF 1 LB./1000 SF. AND ANNUAL RYEGRASS AT 1 LB. PER 1000 SF.
- MULCH STOCKPILE WITH STRAW OR HAY AT AT RATE OF 90 LBS./1000 SF.
- APPLY A LIQUID MULCH BINDER OR TACK TO STRAW OR HAY MULCH.

- a. APPLY TOPSOIL TO A DEPTH OF 5 INCHES (UNSETTLED).
- b. APPLY GROUND LIMESTONE AT A RATE OF 90 LBS. PER 1000 SF. AND WORK FOUR INCHES INTO SOIL.
- c. APPLY FERTILIZER (10–20–10) AT A RATE OF 11 LBS./1000 S.F.
- d. APPLY ATHLETIC FIELD MIX: KENTUCKY 31 TALL FESCUE SEED AT 2 LBS./1000 S.F. CHEWING GRASS RED FESCUE AT 0.7 LBS./1000 S.F. CREEPING RED FESCUE SEED AT 0.7 LBS./1000 S.F. AND PERENNIAL RYEGRASS SEED AT 0.7 LBS./1000 S.F.
- e. MULCH STOCKPILE WITH STRAW OR HAY AT RATE OF 90 LBS./1000 S.F.
- f. APPLY A LIQUID MULCH BINDER OR TACK TO STRAW OR HAY MULCH.


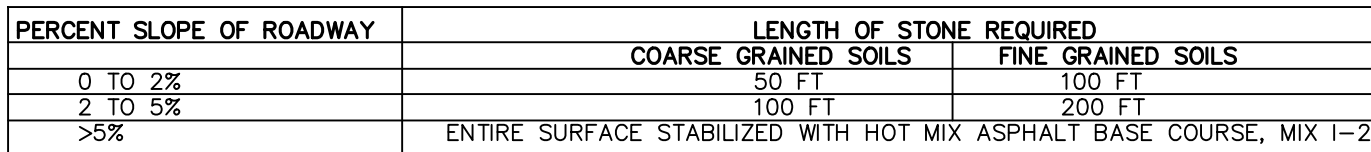
1. ALL TIMBER SHALL BE PRESSURE TREATED AS PER CURRENT STATE AND/OR ASHTO SPECIFICATIONS.
2. ALL TIMBER TO BE GRADED AS PER NFPA 1991 NATIONAL DESIGN SPECIFICATION FOR WOOD CONSTRUCTION
3. STRINGERS AND DIAPHRAGMS ARE TO BE DOUGLAS FIR-LARCH, SELECT GRADE AND ARE TO BE PENTA TREATED AS PER CURRENT STATE SPECIFICATIONS.
4. DECK PLANK IS TO BE SOUTHERN YELLOW PINE, NO. 2 (S4S), AND IS TO BE CCA TREATED AS PER CURRENT STATE SPECIFICATIONS.
5. ALL TIMBER IS ROUGH UNLESS OTHERWISE NOTED.
6. ALL TIMBER CUT IN THE FIELD SHALL BE TREATED WITH AN APPROVED PRESERVATIVE
7. ALL FLOWERS TO BE GALVANIZED AS PER CURRENT STATE SPECIFICATIONS AND/OR ASHTO SPECIFICATIONS M232.
8. CONSTRUCTION REQUIREMENTS SHALL CONFORM TO STATE SPECIFICATIONS
9. ALL TIMBER TO BE CUT TO EXACT LENGTH DRESSED TO SIZE REQUIRED AND ALL PRACTICAL FRAMING TO BE DONE PRIOR TO TREATMENT.
10. TIMBER FABRICATOR SHALL PROVIDE PREFRAMING DETAILS TO ENGINEER PRIOR TO TREATMENT OF MATERIALS
11. 2"x12" BLOCKING SHALL BE PROVIDED FOR JOISTS AT HEADERS AND MID SPAN OR AS REQUIRED BY CODE



1. ANY DISTURBED AREA THAT WILL BE LEFT EXPOSED FOR MORE THAN FOURTEEN (14) DAYS AND NOT SUBJECT TO CONSTRUCTION TRAFFIC SHALL IMMEDIATELY RECEIVE A TEMPORARY SEEDING. IF THE SEASON PROHIBITS TEMPORARY SEEDING, THE DISTURBED AREAS WILL BE MULCHED WITH STRAW OR HAY AND TACKED IN ACCORDANCE WITH THE NEW JERSEY STANDARDS. SEE NOTE 3 BELOW.
2. PERMANENT SEEDING AND STABILIZATION TO BE IN ACCORDANCE WITH THE STANDARDS FOR PERMANENT VEGETATIVE COVER FOR SOIL STABILIZATION COVER. SPECIFIED RATES AND LOCATIONS SHALL BE ON THE APPROVED SOIL EROSION AND SEDIMENT CONTROL PLAN.
3. TOPSOIL STOCKPILE PROTECTION
  - a. APPLY GROUND LIMESTONE AT A RATE OF 90 LBS PER 1,000 SQ. FT. UNLESS A SOIL TEST SPECIFIES OTHERWISE.
  - b. APPLY FERTILIZER (10–10–10) AT A RATE OF 11 LBS. PER 1,000 SQ. FT. UNLESS A SOIL TEST SPECIFIES OTHERWISE.
  - c. APPLY PERENNIAL RYEGRASS SEED AT 1 LB. PER 1,000 SQ. FT. AND ANNUAL RYEGRASS AT 1 LB. PER 1,000 SQ. FT.
  - d. MULCH STOCKPILE WITH UNROTTED SMALL GRAIN STRAW AT A RATE OF 90 LBS. PER 1,000 SQ. FT.
  - e. APPLY A LIQUID MULCH BINDER OR TACK TO UNROTTED SMALL GRAIN STRAW.
  - f. PROPERLY ENTRENCH A SILT FENCE AT THE BOTTOM OF THE STOCKPILE.
4. TEMPORARY SEEDING SPECIFICATIONS
  - a. APPLY GROUND LIMESTONE AT A RATE OF 90 LBS PER 1,000 SQ. FT. UNLESS A SOIL TEST SPECIFIES OTHERWISE.
  - b. APPLY FERTILIZER (10–10–10) AT A RATE OF 11 LBS. PER 1,000 SQ. FT. UNLESS A SOIL TEST SPECIFIES OTHERWISE.
  - c. APPLY PERENNIAL RYEGRASS SEED AT 1 LB. PER 1,000 SQ. FT. AND ANNUAL RYEGRASS AT 1 LB. PER 1,000 SQ. FT. (2/15 – 5/1 OR 8/15 – 10/15) OR PEARL MILLET AT A RATE OF 0.5 LB PER 1,000 SQ. FT. (5/1 – 9/1).
  - d. MULCH SEEDED AREAS WITH UNROTTED SMALL GRAIN STRAW AT A RATE OF 90 LBS. PER 1,000 SQ. FT.
  - e. APPLY A LIQUID MULCH BINDER OR TACK TO UNROTTED SMALL GRAIN STRAW.
5. PERMANENT SEEDING SPECIFICATIONS
  - a. APPLY TOPSOIL TO A DEPTH OF 5 INCHES (UNSETTLED).
  - b. APPLY GROUND LIMESTONE AT A RATE OF 90 LBS PER 1,000 SQ. FT. AND WORK FOUR INCHES INTO SOIL UNLESS A SOIL TEST SPECIFIES OTHERWISE.
  - c. APPLY FERTILIZER (10–20–10) AT A RATE OF 11 LBS. PER 1,000 SQ. FT. UNLESS A SOIL TEST SPECIFIES OTHERWISE.
  - d. APPLY HARD FESCUE SEED AT 2.5 LBS. PER 1,000 SQ. FT. AND CREEPING RED FESCUE SEED AT 1.5 LBS PER 1,000 SQ. FT. AND PERENNIAL RYEGRASS SEED AT 1.0 LBS PER 1,000 SQ. FT. PLANTING SHALL OCCUR BETWEEN 2/1 – 4/30 OR 8/15 – 10/30. PLANTING MAY BE CONDUCTED FROM 5/1 TO 8/14 IF IRRIGATION IS PROVIDED IN ACCORDANCE WITH THE NEW JERSEY STANDARDS.
  - e. MULCH SEEDED AREAS WITH UNROTTED SMALL GRAIN STRAW AT A RATE OF 90 LBS. PER 1,000 SQ. FT.
  - f. APPLY A LIQUID MULCH BINDER OR TACK TO STRAW OR HAY MULCH.

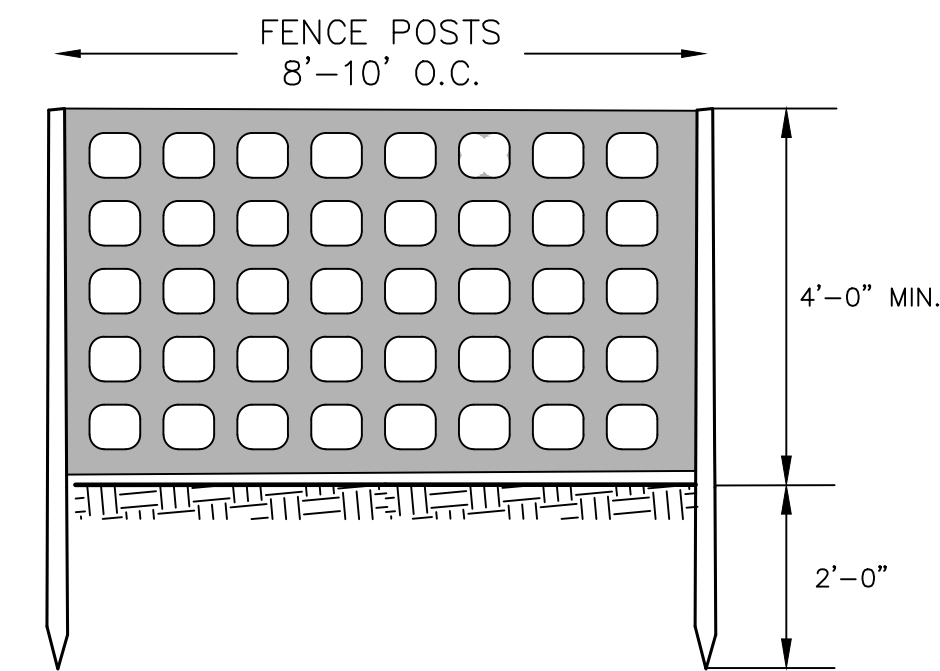

1. BOARDS WILL NOT BE NAILED TO TREES DURING CONSTRUCTION.
2. DAMAGED TRUNKS OR EXPOSED ROOTS SHOULD HAVE DAMAGED BARK REMOVED IMMEDIATELY AND NO PAINT SHALL BE APPLIED. EXPOSED ROOTS SHOULD BE COVERED WITH TOPSOIL IMMEDIATELY AFTER EXCAVATION IS COMPLETE. ROOTS SHALL BE PRUNED TO GIVE A CLEAN, SHARP SURFACE AMENABLE TO HEALING. ROOTS EXPOSED DURING HOT WEATHER SHOULD BE IRRIGATED TO PREVENT PERMANENT TREE INJURY.
3. TREE LIMB REMOVAL, WHERE NECESSARY, WILL BE DONE AS NATURAL TARGET PRUNING TO REMOVE THE DESIRED BRANCH AS CLOSE AS POSSIBLE TO THE BRANCH COLLAR. THERE SHALL BE NO FLUSH CUTS AND NO TREE PAINT SHALL BE APPLIED.



**ENGINEERS - PLANNERS - SURVEYORS - SCIENTISTS**

330 PHILLIPS AVENUE	180 MAIN STREET P.O. BOX 571	17 MODEL AVENUE
SOUTH HACKENSACK NJ 07806	CHESTER NJ 07930	HOPEWELL NJ 08525
TEL: (201) 641-0770	TEL: (908) 879-6209	TEL: (609) 466-0002
FAX: (201) 641-1831	FAX: (908) 879-6597	FAX: (609) 466-2008

**N.J. CERTIFICATE OF AUTHORIZATION No. 24GA27958000**

PROFESSIONAL ENGINEER N.J. LIC. 32978

ESSEX COUNTY NEW JERSEY

CADD FILE: 23NC103\_BASEMAP.DWG

SHEET 5 OF 8











PERFORATED ACRYLIC BACKBOARD 42" X 72" MODEL #660-PF-UG AS SUPPLIED BY JAYPRO, INC. OR EQUAL

BASKETBALL GOAL MODEL #UBG-500 AND NYLON NET, MODEL # JNY-6HP AS MANUFACTURED BY JAYPRO, INC. OR EQUAL (INCLUDED IN UNIT PRICE BID FOR ITEM #4)

BOLT-ON BACKBOARD EDGE PADDING, MODEL #MBBP-6, AS MANUFACTURED BY JAYPRO, INC. OR EQUAL (INCLUDED IN UNIT PRICE BID FOR ITEM #4)

GALVANIZED OUTRIGGER, MODEL #66R, AS MANUFACTURED BY JAYPRO SPORTS INC. OR EQUAL INCLUDED IN UNIT PRICE BID FOR ITEM #4

SQUARE POST, MODEL 666U AS MANUFACTURED BY JAYPRO SPORTS INC. OR EQUAL INCLUDED IN UNIT PRICE BID FOR ITEM #4

72" TYP. FACE OF POLE TO FACE OF BACKBOARD


6" POST PADDING, MODEL PP-66 AS MANUFACTURED BY JAYPRO SPORTS, INC. OR EQUAL (NO LETTERING) INCLUDED IN UNIT PRICE BID FOR ITEM #4

ARTS)


MATERIAL  
H OF  
COURT SURFACE

NOTES:

1. SYSTEM SHALL BE THE "THE TITAN" GALVANIZED POST WITH PERFORATED BACKBOARD, AS MANUFACTURED BY JAYPRO SPORTS INC., WATERFORD, CT, OR EQUAL.

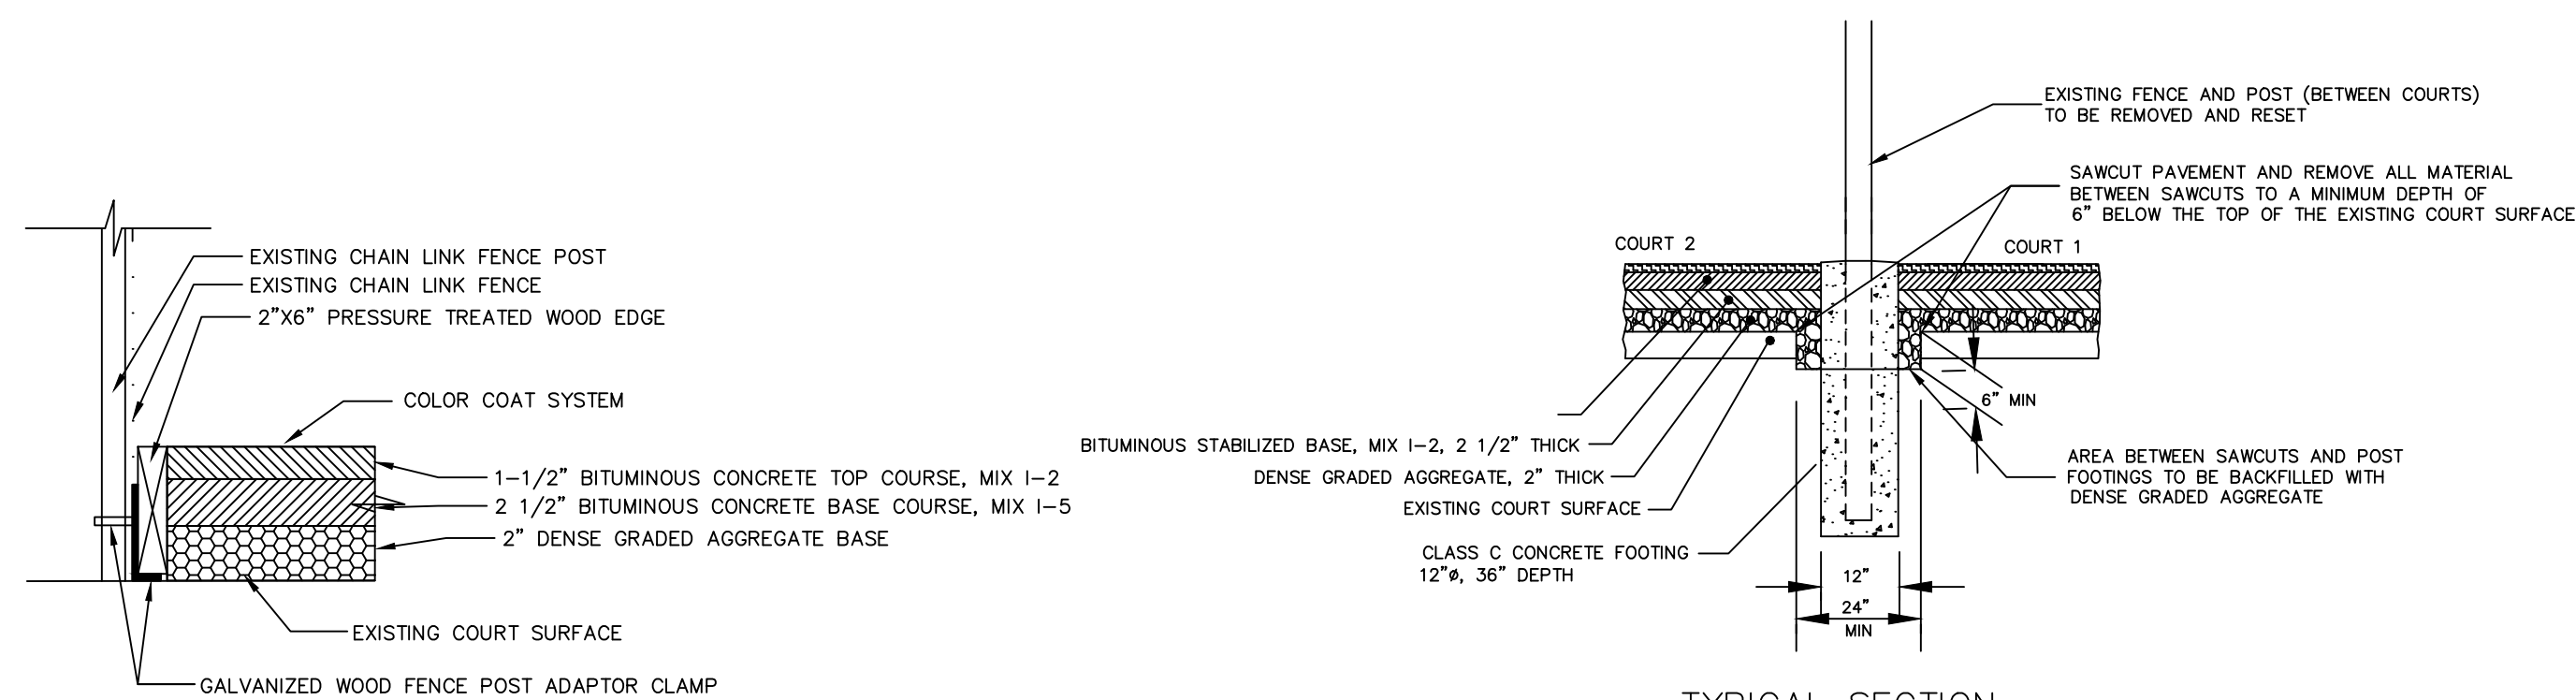

TYPICAL TENNIS COURTS

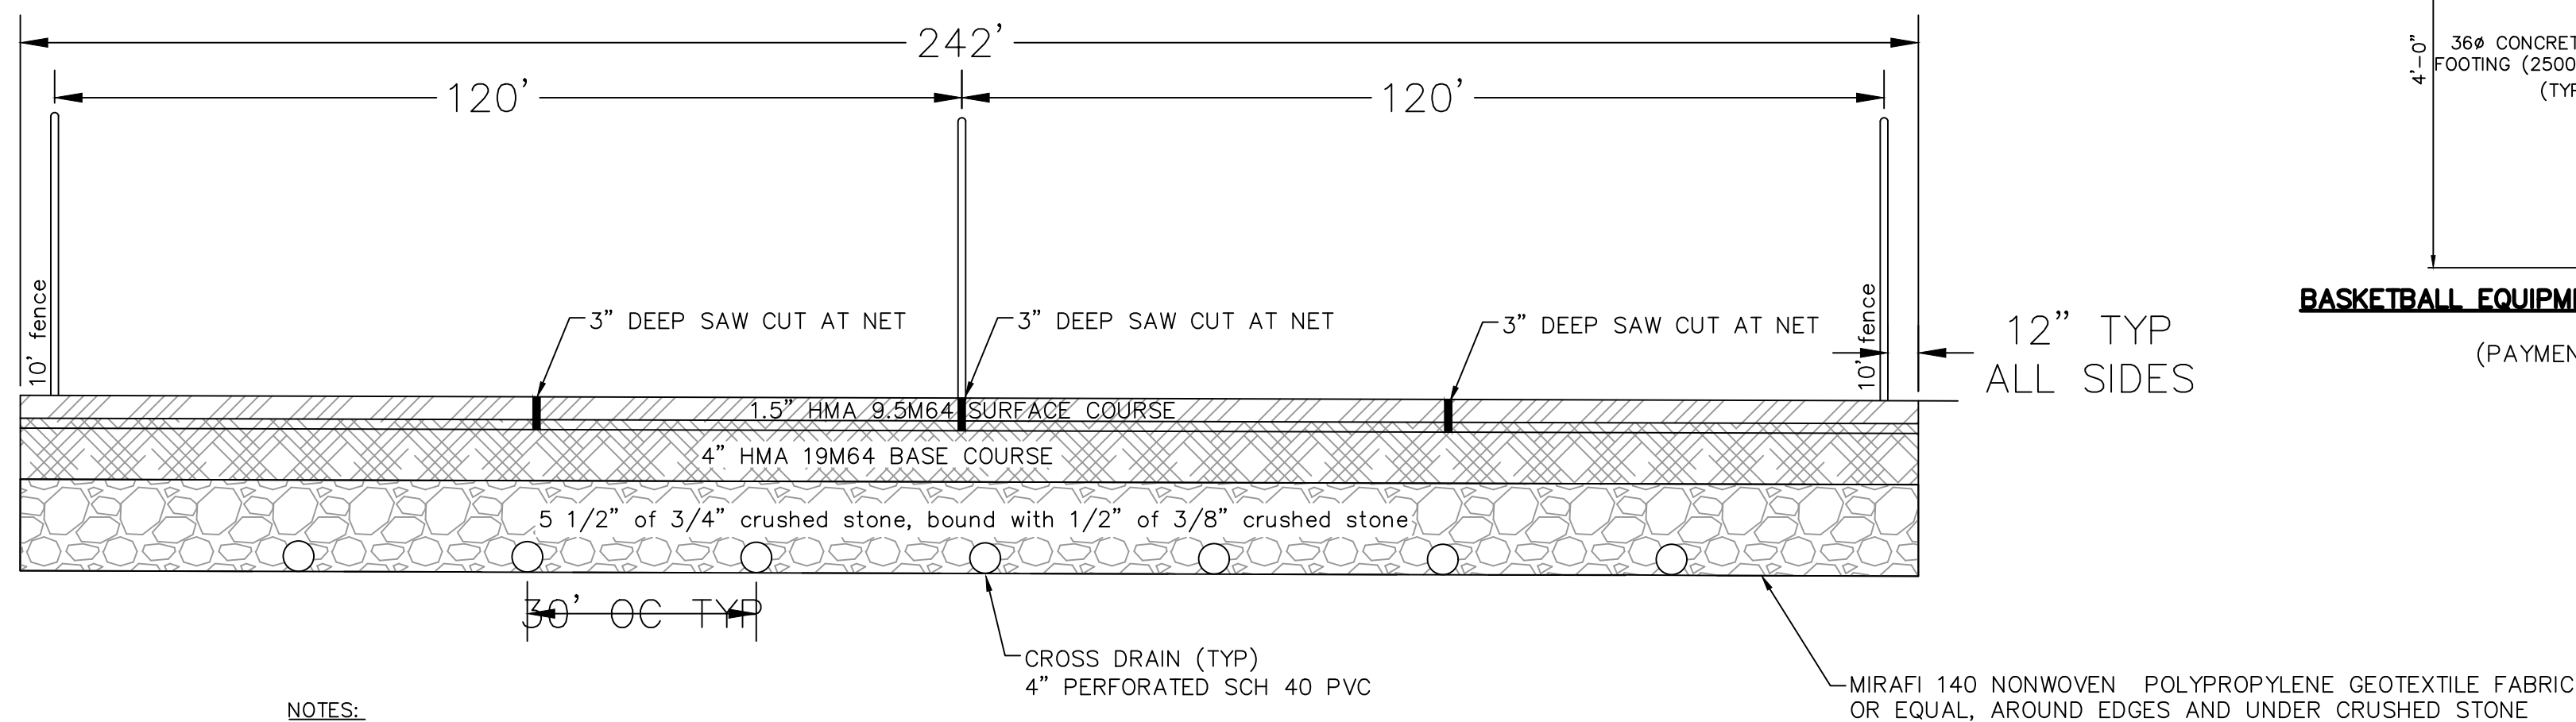


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The image shows two orthographic views of a tapered tower. The side view is on the left, showing a tapered structure with a base width of 8 feet, a top width of 4 feet, and a height of 16 feet. The front view is on the right, showing a rectangular structure with a base width of 6 feet and a height of 16 feet. The front view also includes a detail of a bolted connection.

**SIDE VIEW**  
NTS


**FRONT SIDE VIEW**  
NTS

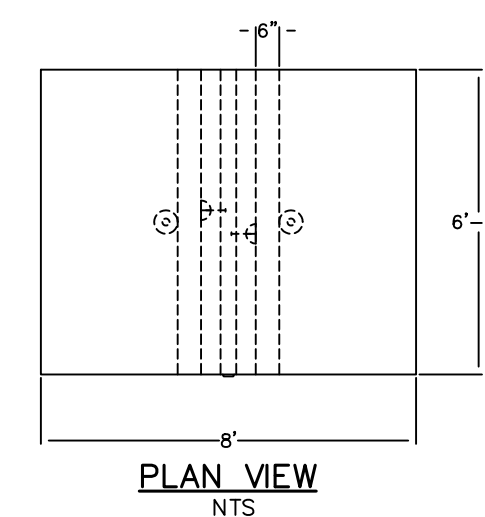

- LACROSSE WALL DETAIL**  
NTS  
(PAYMENT ITEM #x)

## DRAFT

CADD FILE: 23NC103\_BASEMAP.DWG SHEET 8 OF 8

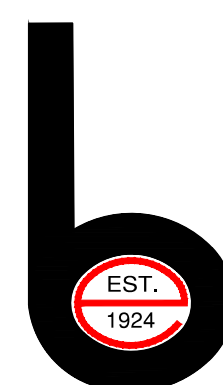[illegible]

# BOSWELL ENGINEERING

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ENGINEERS - PLANNERS - SURVEYORS - SCIENTISTS

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